



PROPOSED





FRONT ELEVATION
1:100

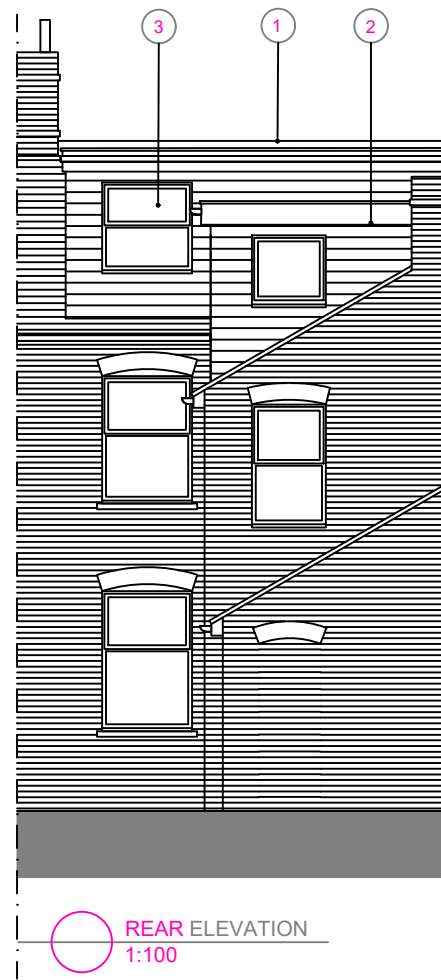

REAR ELEVATION
1:100

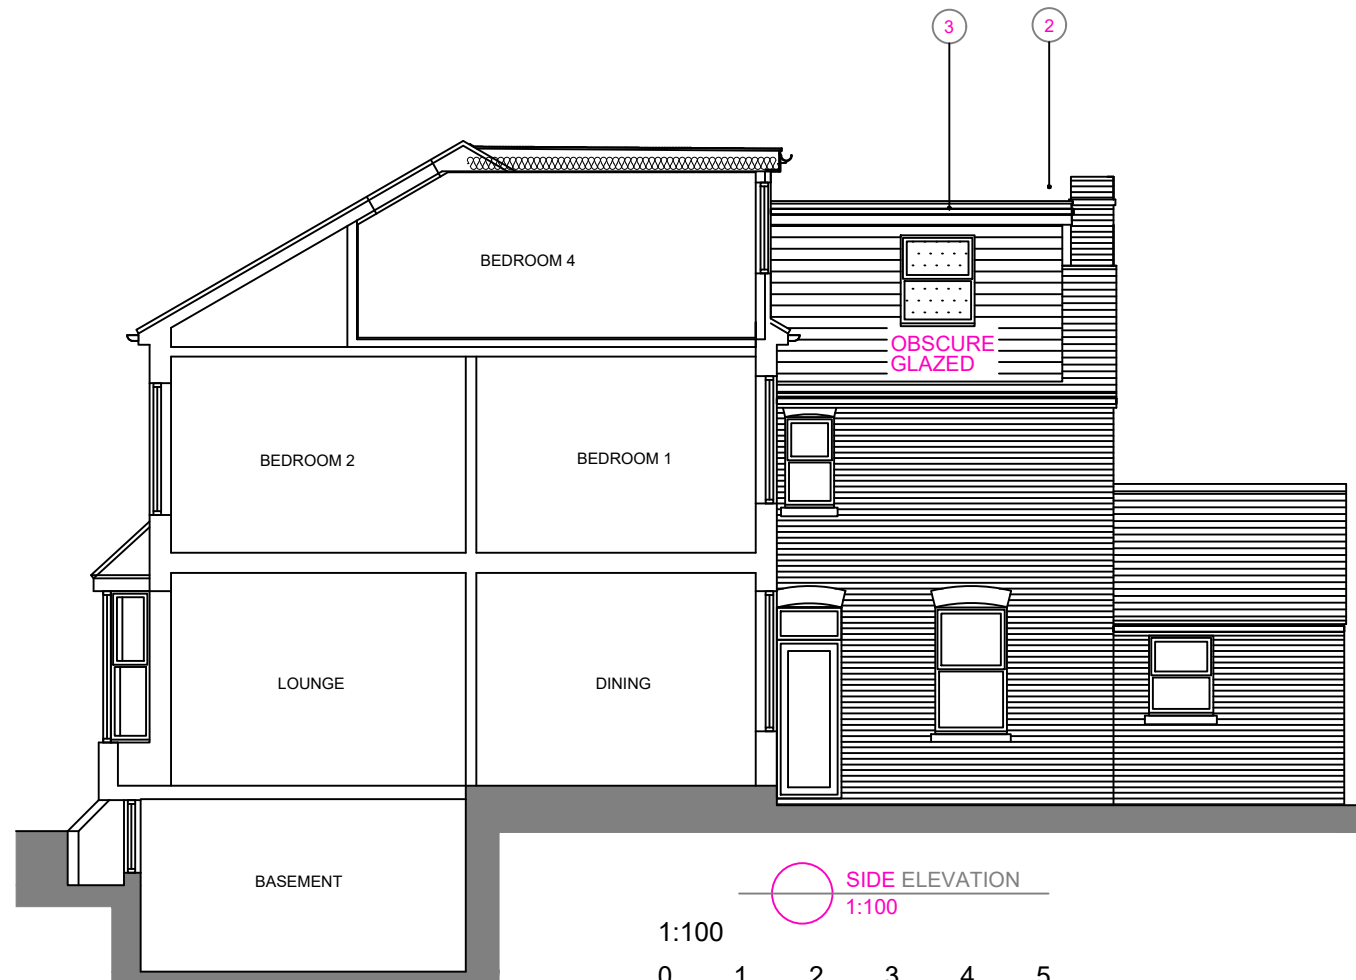

SIDE ELEVATION
1:100

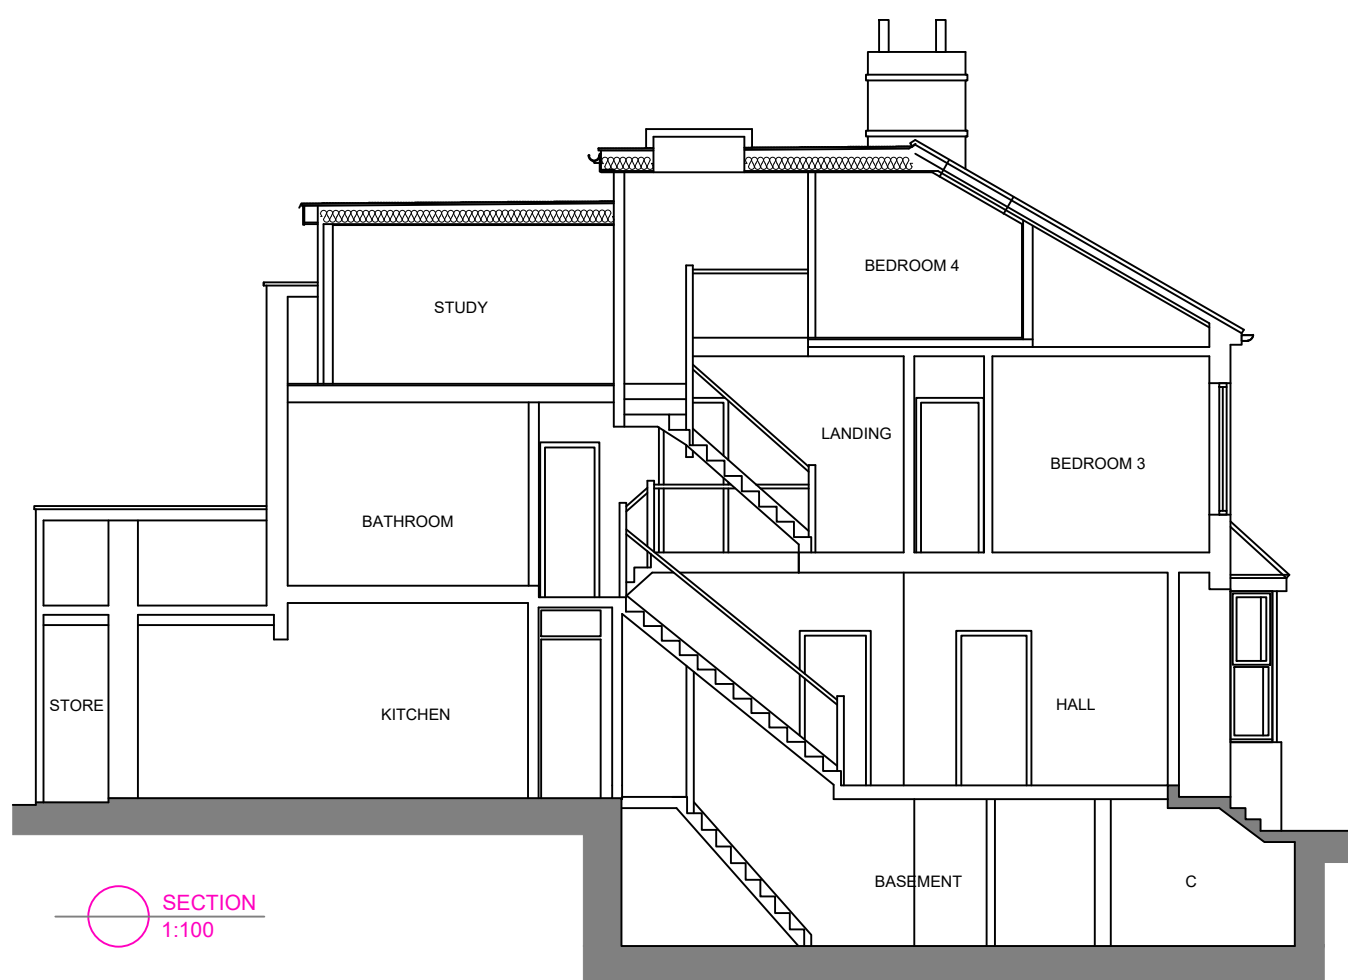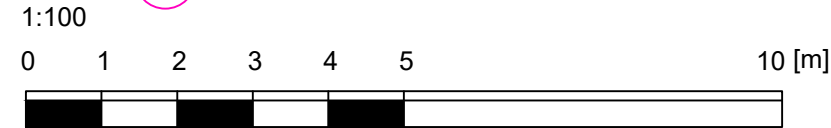


SECTION
1:100



SIDE ELEVATION (From neighbours side)
1:100




VOLUME CALCULATION
NEW DORMER A = 2.25 x 5.0 x 3.95 x 0.5 = 22.2M³
NEW DORMER B = 4.6 x 3.75 = 17.25M³
TOTAL = 17.25M³ + 22.2M³ = 39.45M³

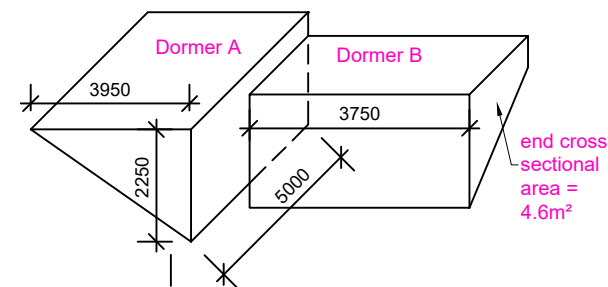


- MATERIAL SCHEDULE
- 1 SINGLE PLY ROOFING MEMBRANE
 - 2 PLAIN TILE HANGING
 - 3 uPVC WINDOWS
 - 4 ROOF WINDOWS




PROPOSED BLOCK PLAN
1:500

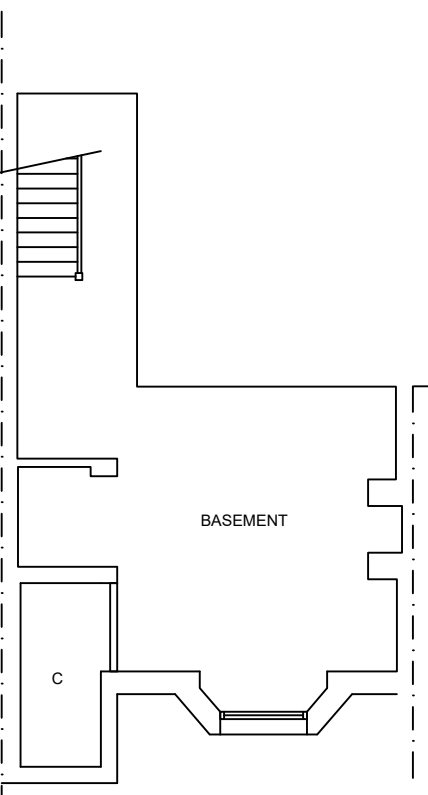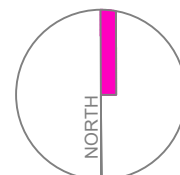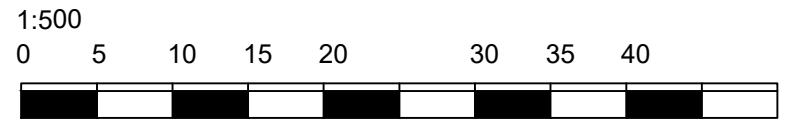


BASEMENT FLOOR PLAN
1:100

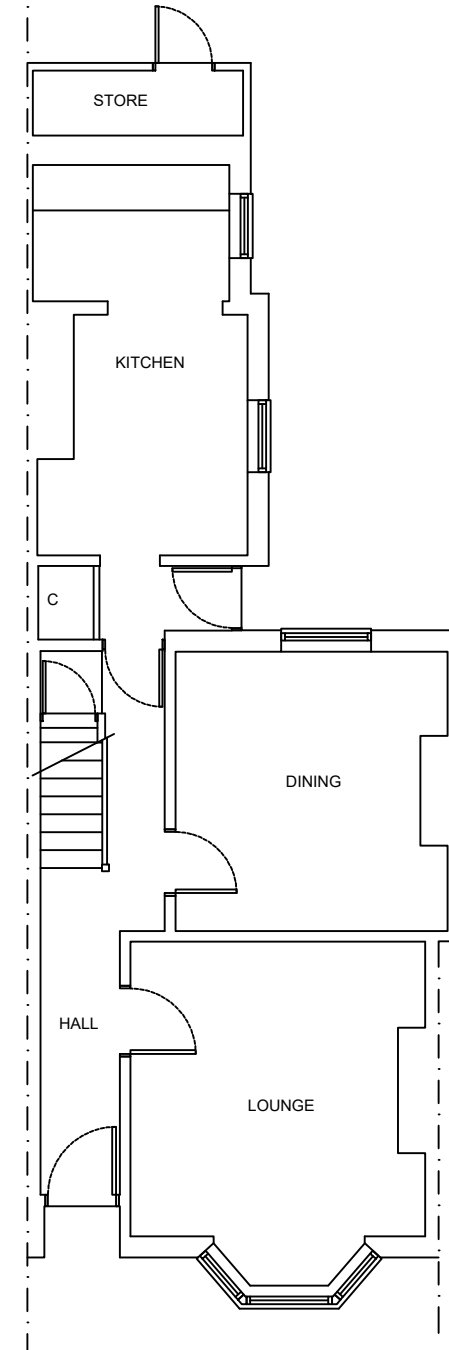


GROUND FLOOR PLAN
1:100

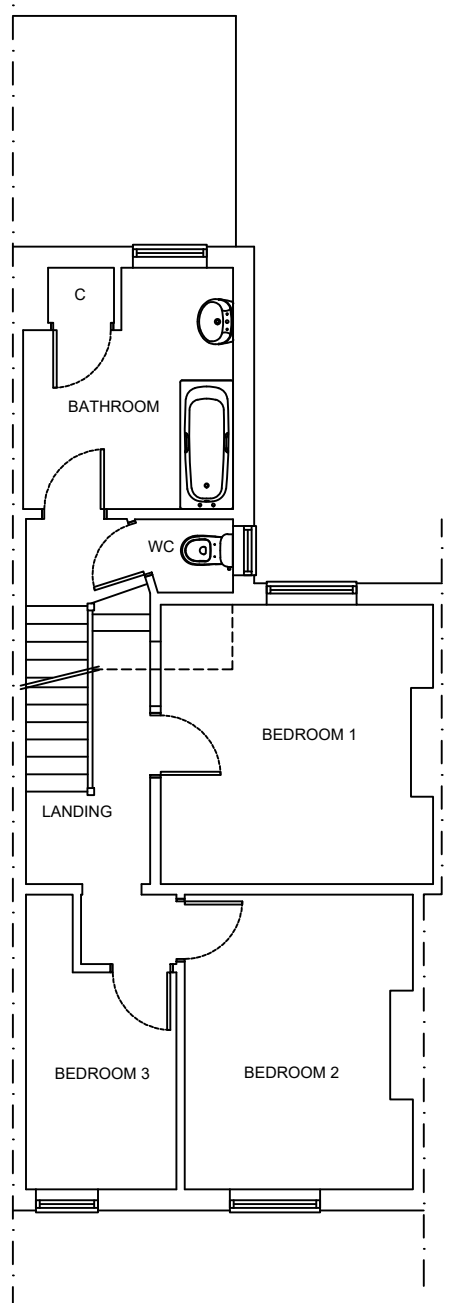

FIRST FLOOR PLAN
1:100

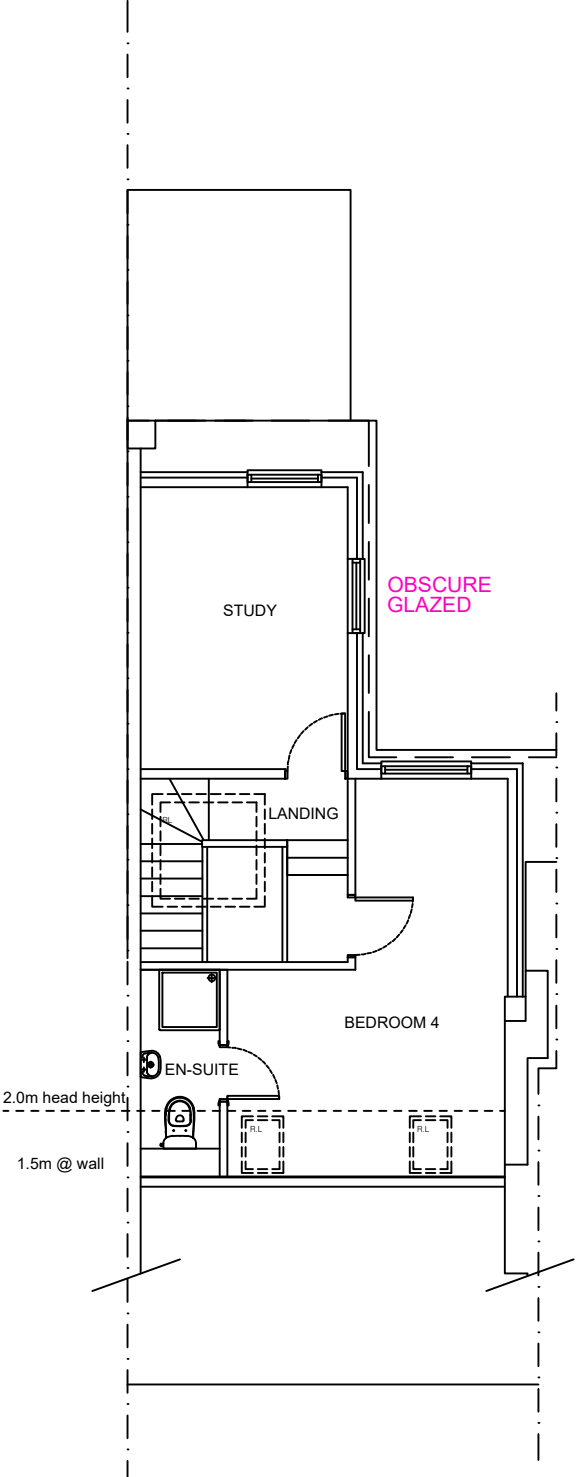

SECOND FLOOR PLAN
1:100

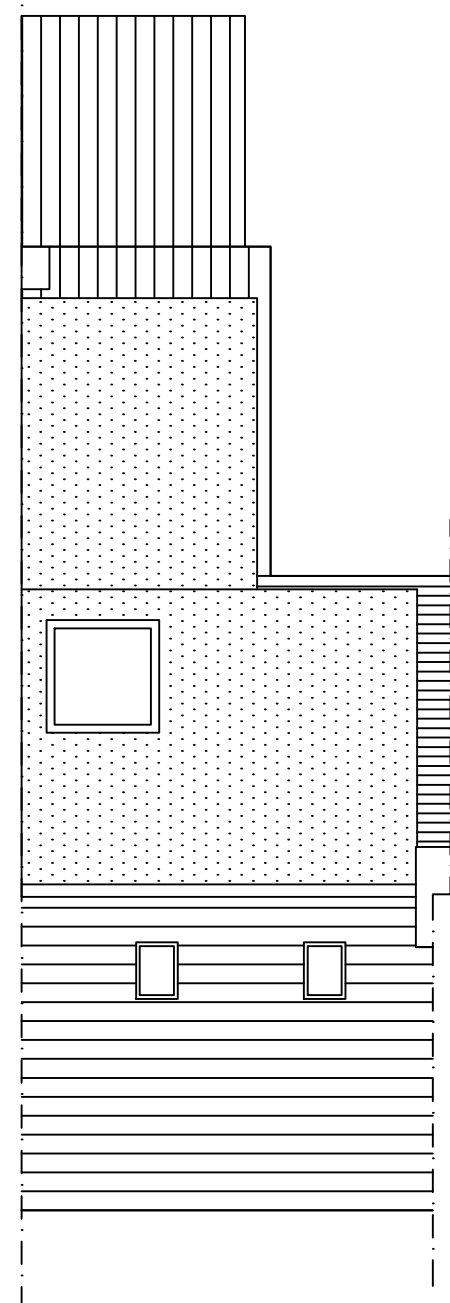

ROOF PLAN
1:100

JOB TITLE 51 UPPER FANT ROAD MAIDSTONE KENT ME16 8BP	DRAWING TITLE PROPOSED PLANS, ELEVATIONS & BLOCK PLAN
SCALE 1:100@A2	DRAWING NUMBER BDS-1739-P52
DATE MAY 22	REVISION

