**IMPORTANT NOTE: A Party Wall** agreement may be required for these works. See information in the adjacent titleblock for further details

General notes: This drawing must be read in conjunction


1289-01 Plans as Existing

1289-02 Elevations as Existing 1289-03 Elevations as Proposed

1289-04 Ground Floor Plan as Proposed 1289-05 Loft Plan as Proposed

1289-06 Section as Proposed

1289-07 B.R. Specification 1289-08 Typical Drainage Details

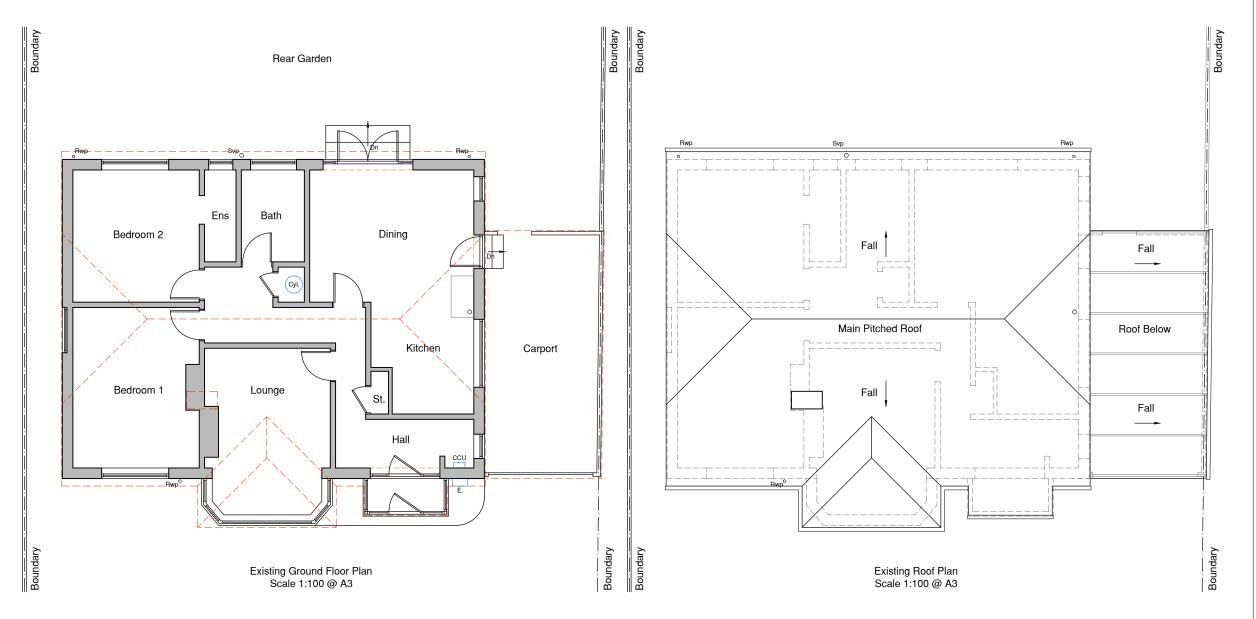

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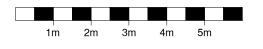
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	Rev	Date	Description

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Planning & Design Consultants

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Mr & Mrs Tolhurst, Inglewood, The Common, Sissinghurst, Kent. TN17 2HU.

#### **Loft Conversion & Side Extension** Floor Plans Existing

Date:	16/10/2021	Drawing Number:
Scale:	1:100 @ A3	1200 01
Drawn:	G.J.O.	1289 - 01
Checked:	S.W.	Revision: -

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All flashings, valleys, drips and soakers to the Lead Development Associations details

## **IMPORTANT NOTE: A Party Wall** agreement may be required for

these works. See information in the adjacent titleblock for further details





General notes: This drawing must be read in conjunction


1289-01 Plans as Existing 1289-02 Elevations as Existing

1289-03 Elevations as Proposed 1289-04 Ground Floor Plan as Proposed

1289-05 Loft Plan as Proposed 1289-06 Section as Proposed

1289-07 B.R. Specification 1289-08 Typical Drainage Details



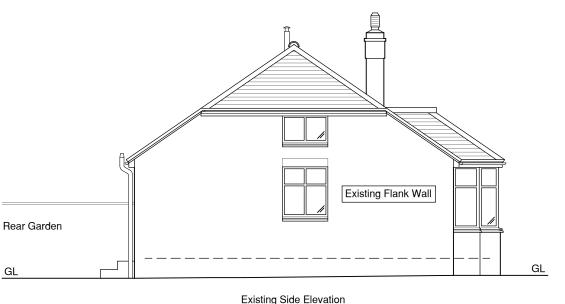

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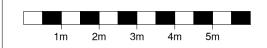
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Rev	Date	Description

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Mr & Mrs Tolhurst, Inglewood, The Common, Sissinghurst, Kent. TN17 2HU.

#### Loft Conversion & Side Extension Elevations Existing


Date:	16/10/2021	Drawing Number:	
Scale:	1:100 @ A3	1289 - 02	
Drawn:	G.J.O.		
Checked:	S.W.	Revision: -	

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Original Drawing Size A3

All flashings, valleys, drips and soakers to the Lead Development Associations details

# IMPORTANT NOTE: A Party Wall agreement may be required for these works. See information in the adjacent titleblock for further details

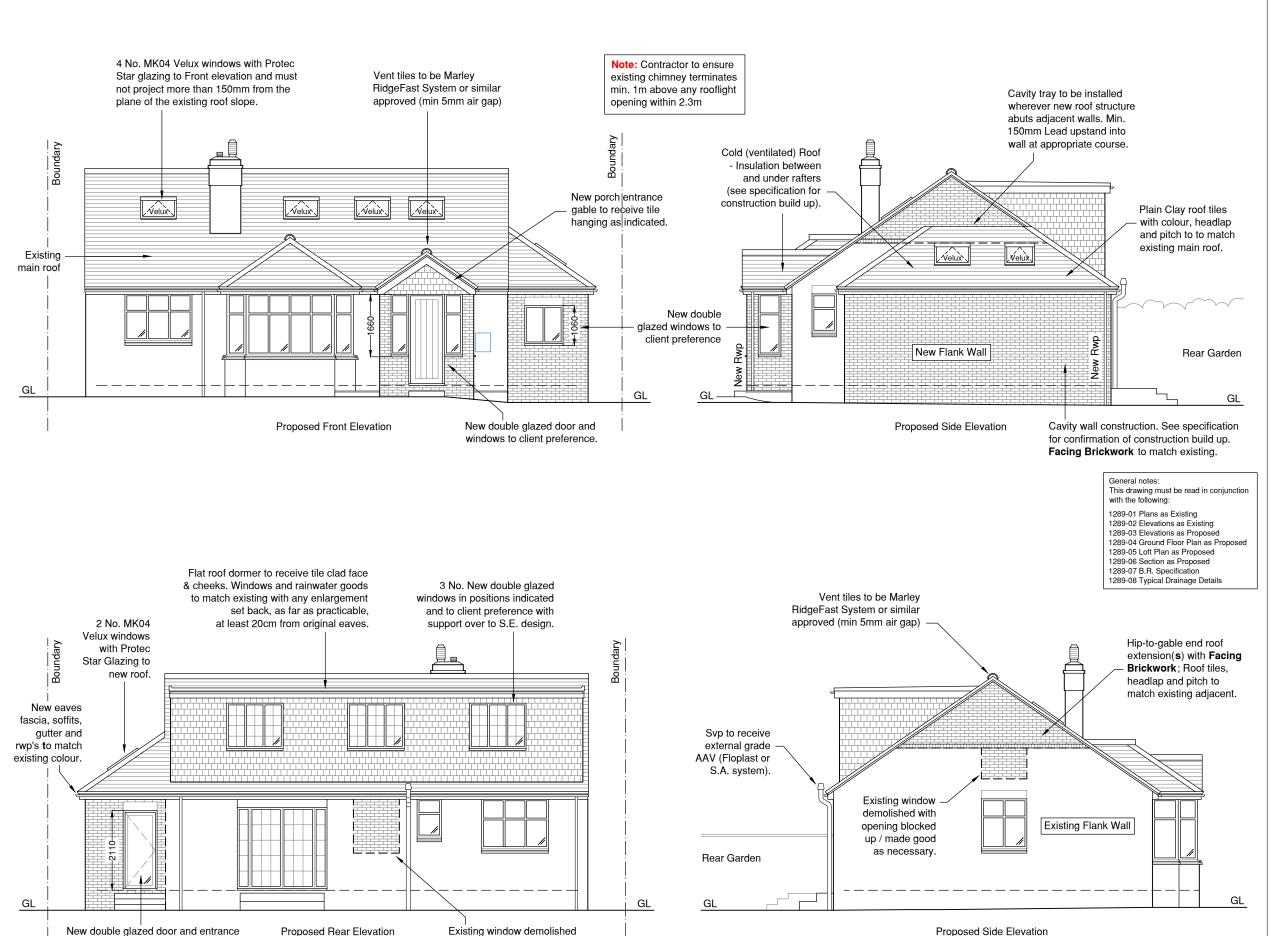

with opening blocked up /

made good as necessary.

The location of the boundary shall be confirmed and agreed with the adjacent owner. No part of the works shall be constructed so that it effects a trespass upon the adjacent property. All work shall be undertaken in accordance with the Party Wall agreement 'The Party Wall Act of 1995'. An agreement should also be obtained from the adjoining owner in respect to access to neighbouring properties for the purpose of construction.

All work shall be carried out in strict accordance with the British Standard Codes of Practice and respective Manufacturers' Instructions.

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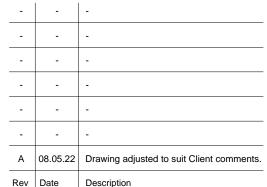
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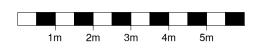
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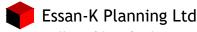
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Project Title

Mr & Mrs Tolhurst, Inglewood, The Common, Sissinghurst, Kent. TN17 2HU.

Drawir

#### Loft Conversion & Side Extension Elevations Proposed

Date:	16/10/2021	Drawing Number:	
Scale:	1:100 @ A3	1289 - 03	
Drawn:	G.J.O.		
Checked:	S.W.	Revision: A	

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Original Drawing Size A3

steps to client preference (quantity to

suit change in levels - T.B.C.).

existing drainage route. This is to be with structural engineer's inspected PRIOR to commencement drawings/details and calculations dates being agreed to allow sufficient No work is to be commenced until time for any design adjustment to be approved by the LABCO or agreements site dimensions have been put in place with the local water authority. checked & discrepancies reported Newly formed surface water Kitchen & Wc room layouts indicative. drainage to be laid to the Client to agree final design & LABCO approval on site and specification prior to commencement is to be connected to a new of works. Pipework connected to soakaway sited minimum existing drainage as necessary. All 5.0m from any building drainage details T.B.C. on site prior to subject to site investigation Rear Garden 1 No. New double glazed door and commencement of works (Class G) by the contractor prior to the (any external landscaping works excluded) entrance steps to client preference (quantity commencement of works. to suit change in levels - T.B.C.). with lintel / Note - where new cavity wall Note: All newly enclosed external beam support over to S.E. design. See abuts existing house either walls to recieve plaster finish. elevations for confirmation of extent. 1) install new vertical damcor If adjacent (existing) floor is insulated dpc dressed into suspended ensure continuation of saw cut to existing wall; New studwork wall Existing window demolished ventilation path via airbricks on new Existing lintels exposed to Existing window demolished with opening (opening enlarged) with new positioned to suit stair design determined suitability for external facade via below ground door as indicated with blocked up / made good as requirements and bathroom increased loading (if pipework to LABCO approval. 2) expose and join existing and support over to S.E. design. required). S.E. to advise. necessary. Facing size (client to confirm). Dn new wall construction for All to the LABCO approval. brickwork to match existing. continuation of cavity. New RWPs to be provided 10mm movement joint between with rodding access plate new wall and existing to be filled and to discharge to with fosroc expandfoam Rwp soakaway (min. 1:40 falls) compressible filler and pointed with fungicidal silicone mastic to match brick colour. Cavity wall construction. Facing Contractor to ensure floor New wall to be tied to existing Brickwork to match existing. Existing ensuite wall and rimming is positioned to 762 door external walls using ancon staifix See specification for confirmation opening demolished with area allow sufficient headroom (830 S/O) universal wall starter system of construction build up. Note: blocked up / made good to Utility to new stairs below. installed in accordance with S.E. to confirm movement joint suit new works adjacent. manufacturers written instructions locations to LABCO approval. Note: Ensure interlinked smoke Bedroom 2 Bath Existing door opening Dining detectors are fitted within hallway (Layout T.B.C.) blocked up / made good as -1830& all landings with a heat New Floor: 150mm O/A beam indicated with new studwork detector installed within kitchen wall adjacent forming Utility / & block flooring system as Existing Kitchen, Ensuite & onto the same system. Carbon designed by specialist supplier Bathroom fixtures and fittings, Kitchen areas as indicated. monoxide detector should be with minimum 150mm (ventilated) associated pipework & cabling installed adjacent any new boiler. void directly beneath adequately removed with surfaces made New stairs to be Existing walls, doors & windows good to suit new layout. All to treated as necessary. Extract fans added to new Wc demolished with new steels underdrawn with client agreement & Kitchen areas (wall or ceiling 12.5mm Pb (as req (over) with any abutment piers mounted with exhaust ductwork by BCO) & max. 42° Dashed lines represent 2 No. MK04 to S.E. drawings and details to external walls or via roof over) supporting structure above. Velux roof windows with Protec \_Cyl. should none be present. Positions Star glazing to Side elevation and any duct route T.B.C. on site Final heights to U/S to be installed in strict accordance with ossible) New Beam Over and agreed with client. agreed with client prior to manufacturers guidance. ommencement of works. Existing structure exposed / See specification for Ground assessed prior to removal to floor build up. Finished floor determine supporting level to be flush with existing. requirements (S.E. to advise). Levels to be confirmed on site Rafter Over 762 door (Vaulted Ceiling) Kitchen S.E. to confirm existing walls, Existing ceilings to provide New walls typically supported Existing walls and doors (830 S/O) beams and foundations can minimum 30 minutes min. by centrally loaded trench demolished with area made Ensure heat accept additional loading. Fire resistance, Supplement foundations (S.E. to confirm). good to suit new works as (hd) detector is installed LABCO to agree approach. or renew if necessary All to the approval of the necessary. New doors within in existing kitchen LABCO. Note: Adjust level of existing walls where indicated foundations to suit ground with support over to S.E. design. levels and conditions if required. Bedroom 1 Lounge 762 door MAIN HOUSE (830 S/O) Note: Existing Carport walls, windows, doors, roof and floor structure New studwork walls forming 610 door Existing walls (including foundations) to be (675 S/O) shown solid hatch. enlarged lounge area, hallway demolished with spoil removed from and adjacent store. Final St. -1010 -665site as necessary. Area suitably position to client preference. Any prepared to accept new extension removed walls assessed prior to works to LABCO approval. Any Hall CCU demolition to confirm supporting 1 No. new double glazed retained structure (incl. foundation requirements (S.E. to advise). window in position indicated support) to be exposed / assessed to Existing Lintel (retained) and to client preference with determine suitability for continued use. support over to S.E. design. Rwp' detector fitted within sd nallway & all landings Existing front entrance area demolished with area made good to suit new works. Raised Note to Contractor: concrete area and extent Typical new stair adjusted to client preference with configuration; contractor 1890-—– 300 – క్ల new access step(s) if required. to carry out survey and provide full details Cavity wall construction. Facing Brickwork to prior to construction match existing. See specification for confirmation 1 No. New double glazed door, sidelights and of construction build up. Note: S.E. to confirm Ensure min 2000mm head side facing window to client preference with movement joint locations to LABCO approval. lintel / beam support over to S.E. design. See height throughout flight elevations for confirmation of extent. All flashings, valleys, drips and soakers to the Lead Developmen Associations details Refer to S.E drawings for confirmation of No new construction to all structural elements, sizing and positions exceed boundary line without Proposed Ground Floor Plan neighbour agreement in place. General notes: Scale 1:50 @ A2 This drawing must be read in conjunction with the following: Central heating and electrical wiring Note: All dimensions to structural and any other applicable services to 1289-01 Plans as Existing frame / wall positions. Any dimensions be extended from main house into 1289-02 Elevations as Existing shown **RED** are from internal finishes extension. Existing switches/sockets 1289-03 Elevations as Proposed adjusted to suit new layout. 1289-04 Ground Floor Plan as Proposed 1289-05 Loft Plan as Proposed It is the contractors responsibility to 1289-06 Section as Proposed **IMPORTANT NOTE: A Party Wall** locate electrical cabling, drainage & 1289-07 B.R. Specification

**Important Note:** 

These dwg's to be read in conjunction

1289-08 Typical Drainage Details

Original Drawing Size A2

mains gas pipework on site.

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Should the new works be built near an

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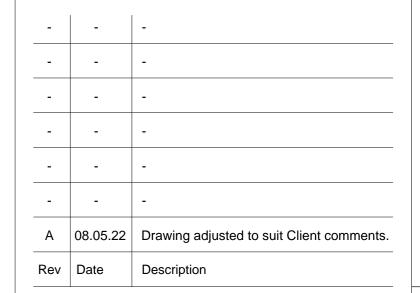
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Project Title:

Mr & Mrs Tolhurst, Inglewood, The Common, Sissinghurst, Kent. TN17 2HU.

Drawing

agreement may be required for

these works. See information in the adjacent titleblock for further details

Loft Conversion & Side Extension Ground Floor Plan Proposed

Date:	16/10/2021	Drawing Number:	
Scale:	1:50 @ A2	1200 04	
Drawn:	G.J.O.	1289 - 04	
Checked:	S.W.	Revision: A	

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