


PROPOSED FRONT ELEVATION
SCALE 1:100

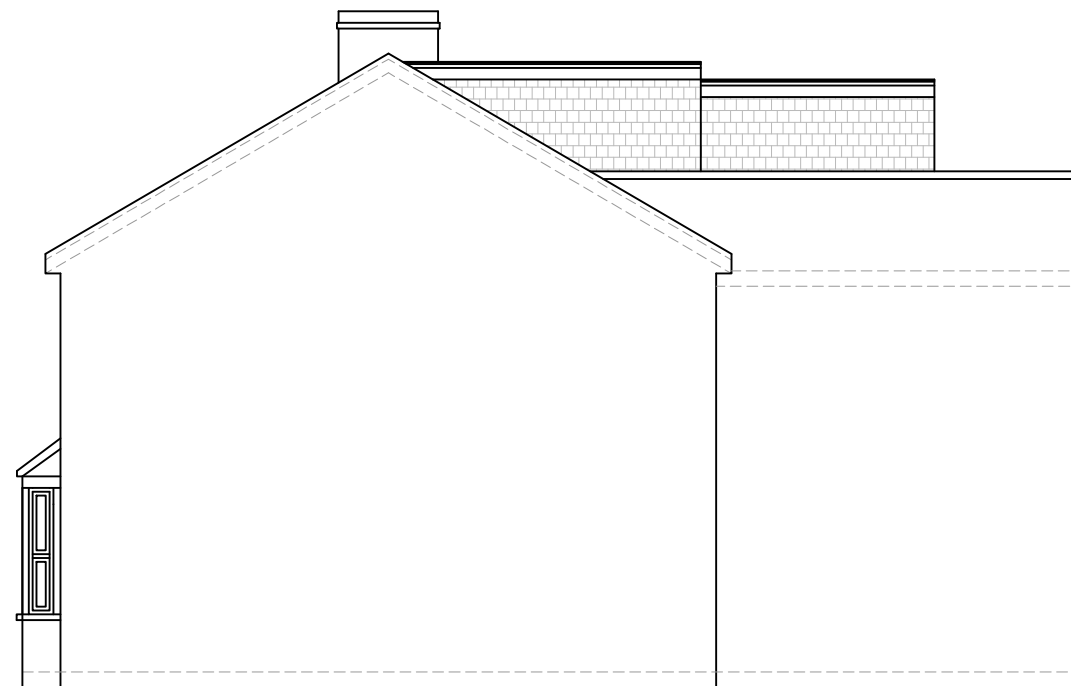

PROPOSED ELEVATION SIDE A
SCALE 1:100

⊗ = LOFT DORMER (A)

$$\frac{\textcircled{A} \quad \textcircled{B}}{2} = \frac{4.24 \times 2.47}{2} = 5.23$$

$$= 5.23 \times 4.61 = 24.13$$

⊙ = LOFT DORMER (B)

$$\frac{\textcircled{A} \quad \textcircled{B}}{2} = \frac{2.39 + 1.33}{2} = 1.86 \times 2.58$$


$$= 4.79 \times 3.15 = 15.11$$

TOTAL VOLUME

$$= X + Y$$


$$24.13 + 15.11 = 39.24$$

$$39.24\text{m}^3 < 40\text{m}^3$$

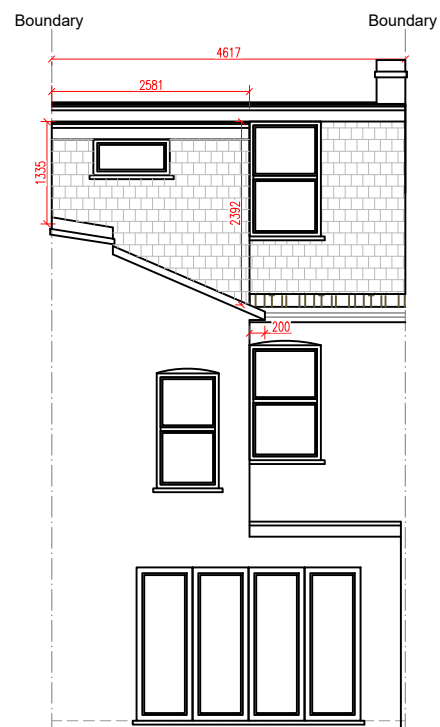


PROPOSED REAR ELEVATION
SCALE 1:100

NEW SIDE FACING WINDOW TO BE
OBSCURE GLASS PLUS FIXED CLOSED
BELOW 1.7M FROM FLOOR LEVEL

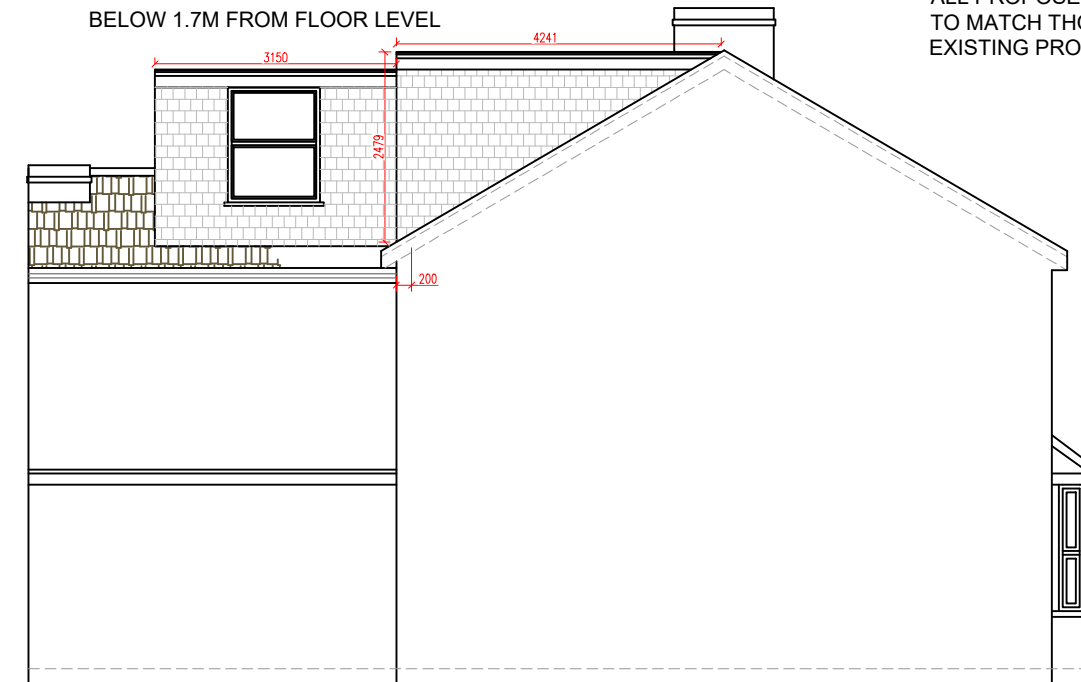

PROPOSED ELEVATION SIDE B
SCALE 1:100

ALL PROPOSED MATERIALS
TO MATCH THOSE OF
EXISTING PROPERTY

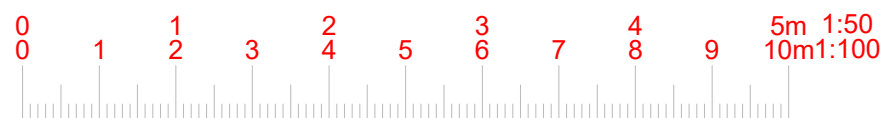

www.FastPlansUK.co.uk

Project: Loft Conversion with
Dormer to Rear.

Address:
90 WHEELER STREET ME14 1UB

Scale: 1:100 @ A3 Dwg. no: A07

Drawn by: O.B.S Date Drawn: 12-AUG-2023

For Drawings Tel: 020 3542 1777

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